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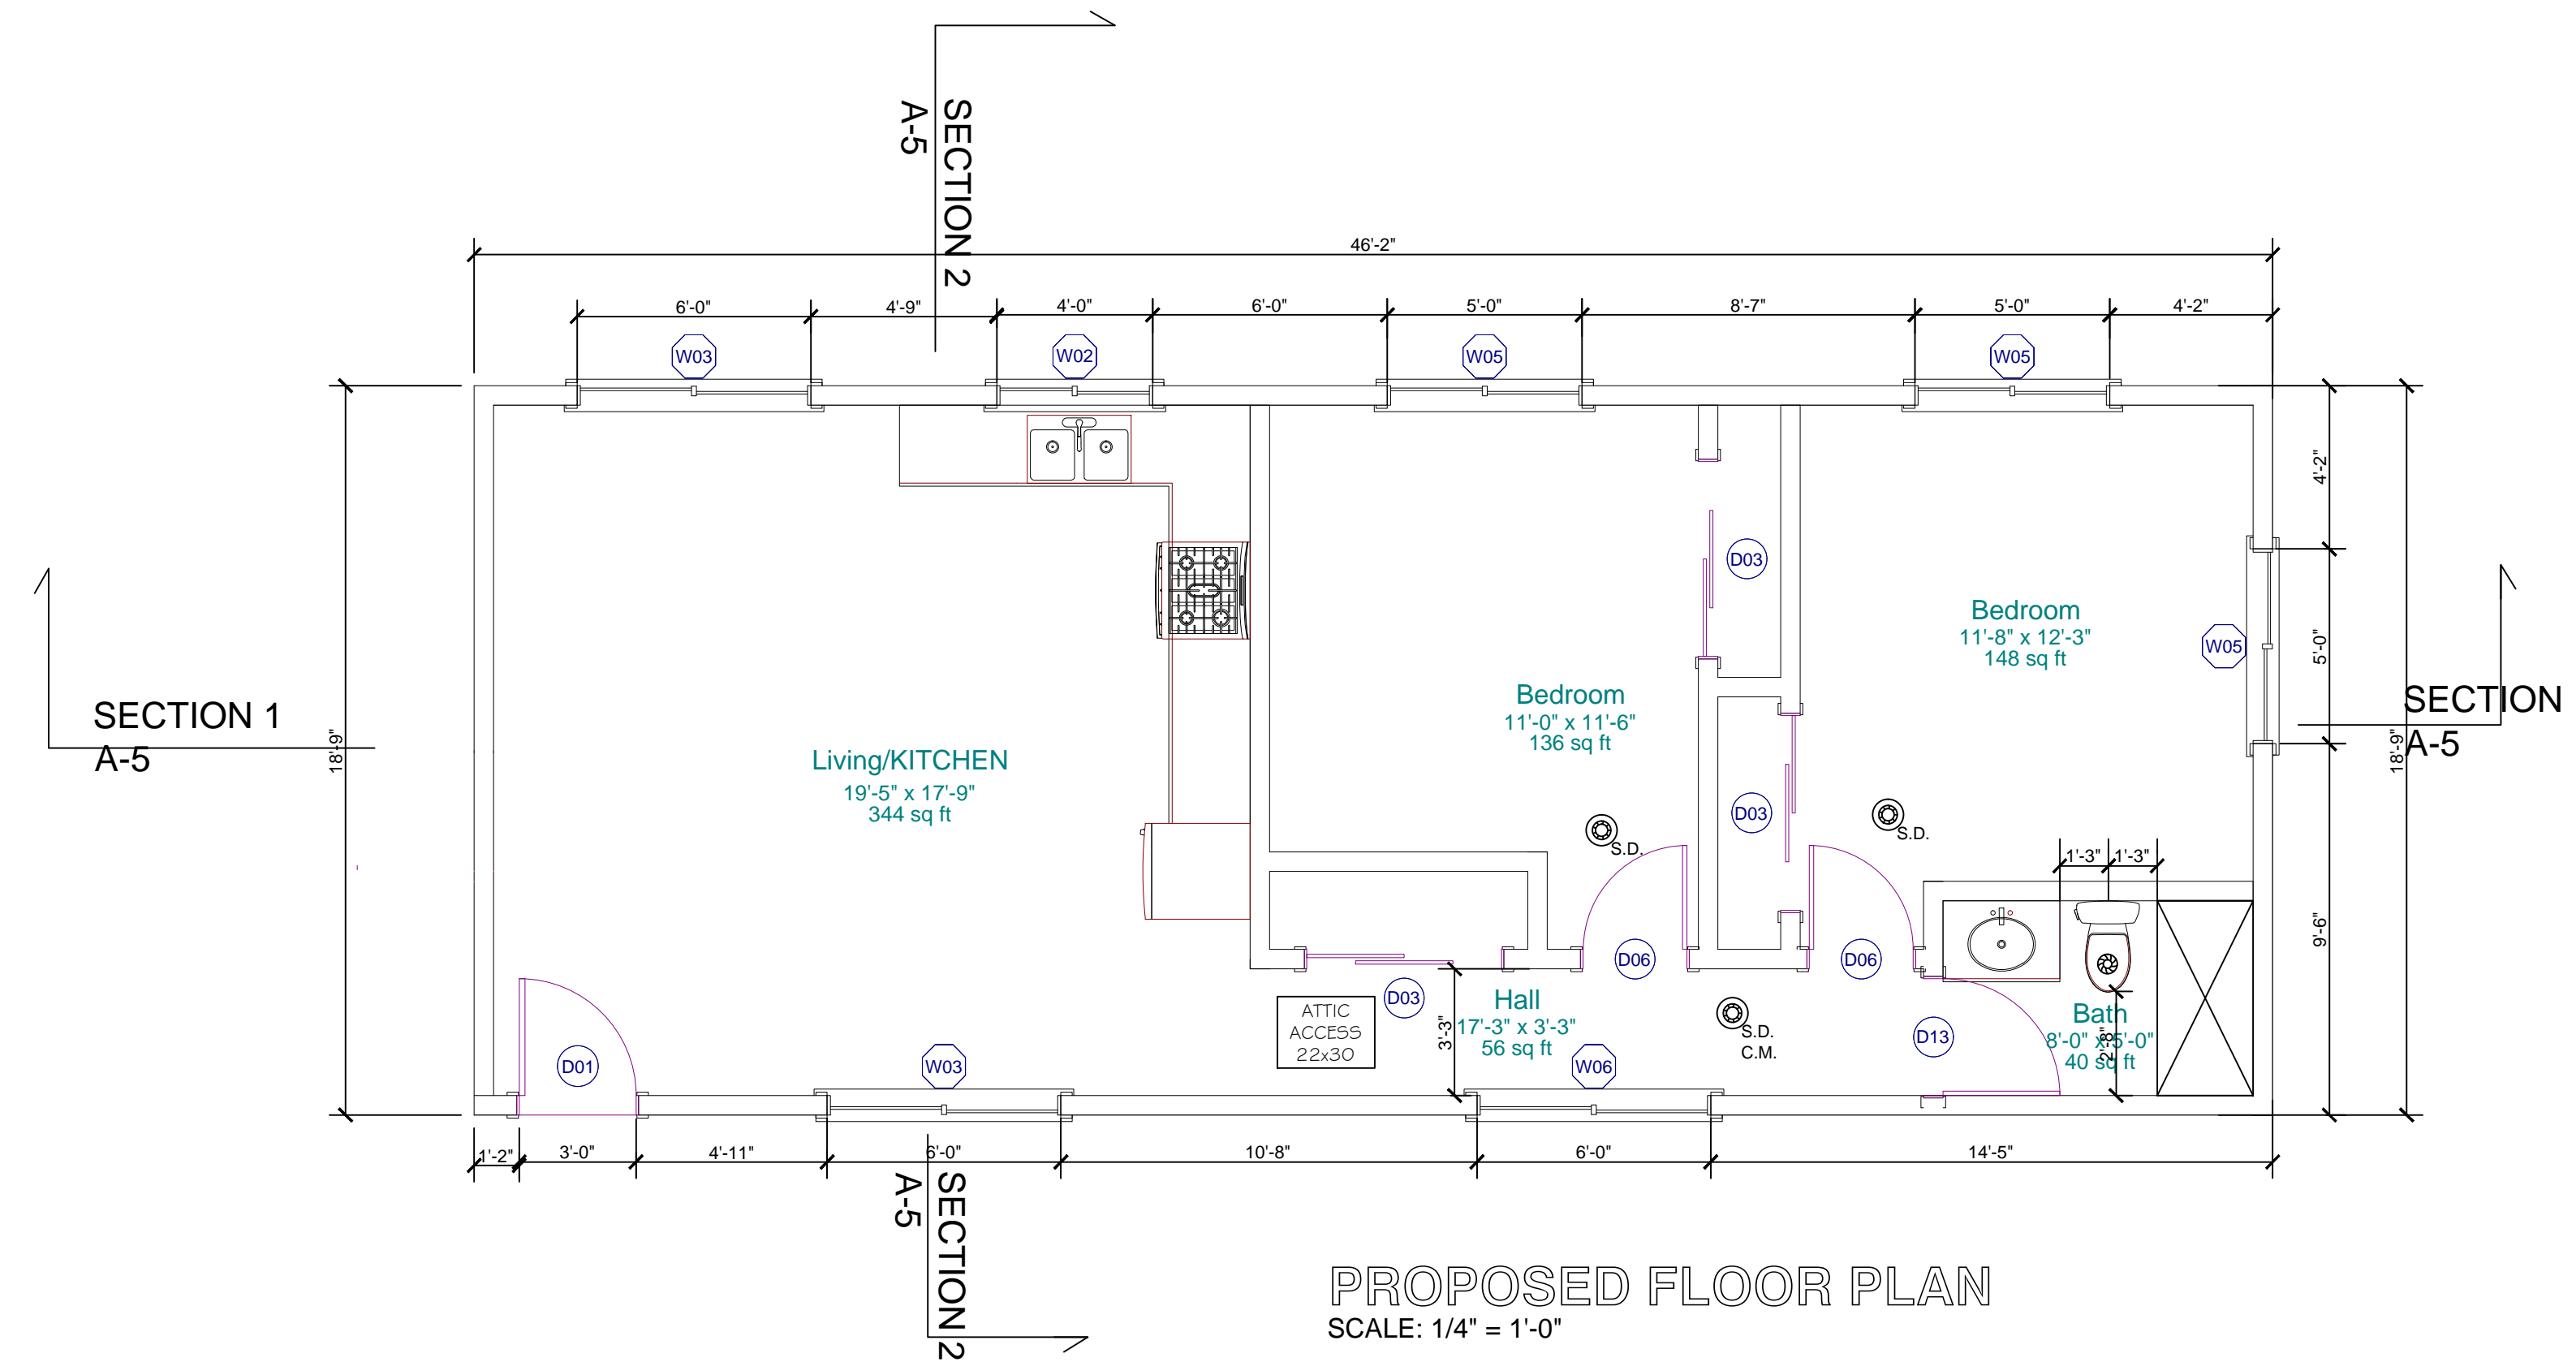
Project Name:
NEW A.D.U.

Project Address:
6942 Longridge Ave
North Hollywood, CA 91605

Scale: 1/4"=1'-0"

DRAWN BY: GREG MISAKYAN
JOB NUMBER: 000-2018
PRINT DATE: 6 / 18 / 2018
SHEET NO:

A-5



Door Schedule							
Number	Qty	Dimensions	Height	R/O	Description	Header	Thickness
D01	2	36"x80"x1 3/4"	80"	37"x81 1/2"	ext. Hinged-Glass	4x4x40"	1 3/4"
D02	1	72"x108"x1 3/4"	108"	73"x109 1/2"	ext. Double Hinged-Glass	4x8x76"	1 3/4"
D03	10	60"x80"x1 3/8"	80"	61"x81 1/2"	Slider-Slab	4x6x64"	1 3/8"
D05	1	48"x80"x1 3/8"	80"	49"x81 1/2"	Hinged-Slab	4x6x52"	1 3/8"
D06	2	32"x96"x1 3/8"	96"	33"x97 1/2"	Hinged-Slab	4x4x36"	1 3/8"
D07	10	48"x96"x1 3/8"	96"	49"x97 1/2"	Hinged-Slab	4x6x52"	1 3/8"
D08	7	72"x96"x1 3/4"	96"	73"x97 1/2"	ext. Double Hinged-Glass	4x8x76"	1 3/4"
D09	2	60"x96"x1 3/4"	96"	61"x97 1/2"	ext. Double Hinged-Glass	4x6x64"	1 3/4"
D10	2	72"x80"x1 3/8"	80"	74 3/8"x81 1/2"	Slider-Slab	4x8x77 3/8"	1 3/8"
D11	2	36"x80"x1 3/8"	80"	37"x81 1/2"	Hinged-Slab	4x4x40"	1 3/8"
D12	1	192"x96"x1 3/4"	96"	193"x97 1/2"	Garage-Garage Door P03	4x8x196"	1 3/4"
D13	4	36"x96"x1 3/8"	96"	37"x97 1/2"	Hinged-Slab	4x4x40"	1 3/8"

Window Schedule								
Number	Qty	Dimensions	Width	Height	R/O	Description	Header	Egress
W01	4	18"x60"	18"	60"	19"x61 1/2"	Fixed Glass	4x4x22"	
W02	1	48"x48"	48"	48"	49"x49 1/2"	Right Sliding	4x6x52"	
W03	5	72"x60"	72"	60"	73"x61 1/2"	Right Sliding	4x8x76"	
W04	2	48"x60"	48"	60"	49"x61 1/2"	Fixed Glass	4x6x52"	
W05	5	60"x60"	60"	60"	61"x61 1/2"	Right Sliding	4x6x64"	
W06	1	72"x24"	72"	24"	73"x25 1/2"	Right Sliding	4x8x76"	

LEGEND

- NEW WALLS
- HARD WIRED SMOKE DETECTOR W/ BATTERY BACK-UP
- MECHANICAL VENT, 50 CFM AIR CHANGE PER HOUR, ENERGY STAR HUMINISTAD SENSOR DIRECTLY TO THE OUTSIDE
- 12" X 12" TUB ACCESS
- DRYER VENT, DIRECTLY TO OUTSIDE MUST BE 1/4" OR LESS
- WATER HEATER
- BALCONY DRAIN PER DETAIL
- GROUND-FAULT CIRCUIT-INTERRUPTER
- EXIT SIGN WITH BATTERY BACK UP POWER
- ATTIC ACCESS 2.2x3.0

ATTIC VENT CALCULATIONS
ATTIC AREA = 802 SQ. FT.
VENT SIZE: 12x24 REQUIRED
802 / 150 = 5.34 SQ. FT.
PROVIDED 8 SQ. FT. > 5.34

